FORM MR-REV (Revised 1/92) cotto, wood #3

FOR DOGM USE ONLY:

STATE OF UTAH
DEPARTMENT OF NATURAL RESOURCES
DIVISION OF OIL, GAS AND MINING

355 West North Temple 3 Triad Center, Suite 350 Salt Lake City, Utah 84180-1203 JUL 2 2 1992

DIVISION OF OIL GAS & MINING

NOTICE OF INTENTION TO REVISE MINING OPERATIONS

When an operator intends to revise a mining operation, a Notice of Intention to Revise Mining Operations shall be filed with the Division. The notice must include all information, concerning the revision, that would have been required if it had been included in the original Notice of Intention (NOI). Ideally, the revision application should be a "stand-alone" document and include all information necessary to conduct a complete review.

"REVISION" means a significant change to the approved Notice of Intention to Conduct Mining Operations, which will increase the amount of land affected or alter the location and type of onsite surface facilities such that the nature of the reclamation plan will differ substantially from the approved Notice of Intention. Revisions require public notice and may require approval by the Board of Oil, Gas & Mining, if a change to the amount and/or form of the reclamation surety is necessary.

"AMENDMENT" is an insignificant change to the approved Notice of Intention. An amendment requires Division approval, but does not require public notice.

The Division will determine whether a request for change is significant or insignificant on an individual case-by-case basis.

PLEASE NOTE:

When applicable, reference to previously approved information contained in the original NOI can be used (identify volume #'s, section, page #, plate/map #'s, & date of submittal). If possible, please attach appropriate copies of the referenced material as part of the application for revision.

Where possible, please format the application to revise mining operations (e.g., text, maps, tables, figures, etc.) to allow direct insertion into the original NOI as replacement pages, or as a separate addendum to the approved NOI.

The operator is encouraged to use this form as a guide only. Please use extra sheets as necessary to complete each section that follows.

The following information must be included as part of the application to revise mining operations:

I. GENI	ERAL INFORMATION (Rule R647-4-104)	
1.	Name of Operator/Applicant: ZIEGLER CHEMICAL & MINERAL	CORPORATION
2.	Name of Company/Corporation: ZIEGLER CHEMICAL & MINE	RAL CORPORATION
3.	Address: 100 JERICHO QUAD, JERICHO, NY11753 UTAH ADDRESS: C/O NORMAN HASLEM, MANAGER, STAR 84078	
4.	Phone: (516) 681-9600	
5.	Name of Mine/Project: COTTONWOOD #3 MINE	
6.	Previously Assigned File Number: (M / S) /047 / 013 *from original Notice of Intention (NOI)	
7.	Location of Proposed Activities:	
COU	NTYUINTAH	
TOW	NSHIP 10 SOUTH, RANGE 21 EAST,	
SECT	TION(S) 29 & 30 (Identify to 1/4, 1/4 section) SW 1/4 of NW 1/4 of Section 29 SE 1/4 of NE 1/4 of Section 30	
8.	Ownership of Land Surface:	
Private (Fee) Owners Name(s):(Private)	
State of	Utah Dublia Damain (DIM) National Forest (USES)	1

9. Ownership of Minerals:	
Private (Fee) Owners Names(s): (Private)	
State of Utah x Public Domain (BLM)	National Forest (USFS)
10. Utah Mining Claim Number(s)	
11. Utah State Lease Numbers(s)	ML 20779 and ML 19868
II. MAPS, DRAWINGS & PHOTOGRAPI	HS (Rule R647-4-105)
Appropriate maps, drawings, plates, etc. should revision, or amendment of mining operations. Propreviously approved and the new proposed disturs should be prepared according to the requirements.	lease provide a revised map outlining the bed area boundaries. These materials of Rule R647-4-105.
List map numbers or appendices used for this sec	
III. OPERATION PLAN (Rule R647-4-106)	3 P63.
Provide a narrative description, referencing any a the pertinent details of the proposed change(s) in which are different from those described in the o Identify additional proposed surface disturbance. affected by the revision or amendment. All approutlined under Rule R647-4-106 must be addressed	the operating plan. Specific details riginal approved NOI should be included. Include the total number of acres to be opriate information requirements as
Refer to Exhibit A attached here	eto.

IV. IMPACT ASSESSMENT (Rule R647-4-109)

	Please provide information as required under Rule R647-4-109 regarding projected potential surface and/or subsurface impacts which may be associated with the proposed change(s) in mining operations.		
	Refer to Exhibit A attached hereto.		
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V	RECLAMATION PLAN (Rule R647-4-110)		
	Describe how you intend to stabilize the disturbed areas upon cessation of operations. This includes backfilling excavations, grading, sloping or contouring, permanent stabilization of slopes or roads, permanent closure of roads, removal of structures and improvements, etc. Provide cross section of the proposed final contour of the land after reclamation.		
	Please outline any proposed changes to the originally approved reclamation plan. Appropriate sections of Rule R647-4-110 must be addressed as they may apply to the proposed change(s) in mining operations.		
_	Refer to Exhibit A attached hereto.		
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VI. VARIANCE (Rule R647-4-112)

	Please identify any requests for variance from the requirements of rules R647-4-107, -108, or -111. A narrative justification must also be included for each variance request. A discussion of any alternate methods or other mitigating measures should be included, if applicable.
	n/a
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_	
_	
V	II. SURETY (Rule 647-4-113)
	Reclamation Surety:
	Indicate whether the proposed activities will change the amount of work required to reclaim the minesite. If significant changes will result, then an itemized reclamation cost estimate should be provided (and attached) with direct reference to the specifics of the proposed change(s). This information will be used to assist the Division in determining any reclamation surety adjustments required for the operation.
	No. Due to minimal surface disturbance reclamation of
	mine site can be accomplished as described in the original
	NOI filed in July 1986.
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VIII. SIGNATURE REQUIREMENT

The application for permit change must include a section similar to the following example:

I hereby certify that the foregoing is true and correct.

Signature of Authorized Officer/Representative:

Name (Typed or Print):

MANAGER, ZIEGLER CHEMICAL VERNAL OFFICE

Title of Authorized Officer/Representative:

Date: 7/20/92

3:MR-REV

POGM REC 7-22-92

Cottonwood #3

EXHIBIT A

III. OPERATION PLAN (Rule R647-4-106)

The proposed mining operation will involve two (2) miners and one hoistman working one shift per day. Mining operations will be conducted through a shaft opening which will be encased in a concrete collar. The shaft walls will extend nearly straight down to a depth where the ore is of sufficient width to be mined. A slope will be created allowing the gilsonite as it is chipped loose to slide down the slope to a bin where an airlift system will convey the gilsonite to the surface, dumping it in a truck loading bin. This mining method is often referred to as the underhand rill method.

A conventional headframe will be placed over the shaft opening and/or hoisted will be transported at the rate of about twenty (20) tons per day to the Ziegler processing plant at Little Bonanza, Utah. This will require hauling an average of one (1) twenty (20) ton truck load of gilsonite per day. During transportation the load of gilsonite will be fully covered by a tarp. The route to be used for hauling the gilsonite consists of unpaved oil field roads and county roads which are maintained and kept open as the weather requires by the oil companies and the county. The route to be used is shown on the map attached as Exhibit B.

The total number of acres to be affected is approximately 1.2

acres and the mineral to be mined is gilsonite.

The proposed mining operation should not require disposal of any overburden since the gilsonite vein comes to the surface in this area. Any waste rock encountered during the mining operation will be left in mined out shafts.

The area surrounding the proposed mine shaft consists of barren hills and dry washes, sparsely vegetated with salt desert shrub, horsebrush, four-wing saltbush, greasewood, black sage, rabbitbrush, and sagebrush. Grasses found include Indian ricegrass, needle and thread, cheatgrass and galleta. The area is too dry to support the growth of any significant quantities of grass or other feed type vegetation, consequently there is minimal animal life present in the area. Wildlife which are occasionally present in the area include rabbits, coyotes, antelope, and birds.

There are gas and oil wells in the general vicinity, the nearest being more than one (1) mile from the proposed mine site. Other than the gas and oil wells there is no known use of, or activity on the land in the immediate vicinity of the proposed operations. Upon completion of mining operations the area will be machine compacted, soil will be tested at a State approved lab and seed bed preparation will follow the recommendations of the State approved laboratory and the area will be regraded. Attached hereto and labeled as Exhibit C are maps showing the site plan, the

vicinity of the mine site and the current and proposed reclaimed areas.

After the gilsonite accessible from the initial shaft has been removed, mining operations will move to the escape shaft site approximately 600 feet to the northwest of the initial mine site. At that time the shaft proposed herein will be preserved as an escape route from the new shaft.

During the time that it is used as an escape way the initial shaft will be maintained in a safe and operable condition and the surrounding area will be fenced. The mine shaft, generator, fuel storage tank and escape shaft will be enclosed within a fence to limit any chance of injury to persons who might wander into the area.

When a mine shaft is no longer needed as an escape way it will be sealed with a cap of 12 inch thick reinforced concrete.

IV. IMPACT ASSESSMENT (Rule R647-4-109)

There will be minimal surface disturbance; ground water will not be affected and there will be no impact on wildlife. There will be no impact on erosion control and air quality. Furthermore, as stated above, precautionary measures will be exercised to ensure that the area will be fenced in for the public health and safety of others.

V. RECLAMATION PLAN (Rule R647-4-110)

Reclamation will be accomplished as described in the original NOI application dated July 1986.

The area consists of sparsely populated grass, horsegrass, greasewood, rabbitbrush and sagebush which is seldom inhabited by rabbits, birds, coyotes and antelope. When mining operations are completed, the land will be returned to its current condition and reclaimed as recommended by a State approved laboratory.

When a mine shaft is no longer needed as an escape way, it will be sevaled with a cap of 12 inch thick reinforced concrete.

After operations are completed, all buildings, machinery and debris will be removed from the site. Any areas where the surface has been disturbed will be regraded to rounded cross sections. Where possible soil material will be placed over the building sites and storage areas after regrading.

Once mining operations are completed, there will be no deleterious or acid forming materials left on the site as a result of mining or mineral processing.

All disturbed soil will be scarified and fertilized prior to reseeding. Reseeding will be based on recommendations of soil tests conducted by a State approved laboratory.

DOGH REC. 7-22-92

ACRES

T10S, R21E, Section 30: SE 1/4 of NE 1/4 of Section

30.

COTTONWOOD GILSONITE MINES

Cottonwood #1

1.24
To be reclaimed in 1992

Cottonwood #2

1.50
To be reclaimed in 1992

Cottonwood #3


1.20
T10S, R21E, Section 29:
SW 1/4 of NW 1/4 of Section 29.

NAME

ZIEGLER CHEMICAL & MINERAL CORP.

Mine Shaft, COTTONWOOD #3, located as shown in the SW 1/4 NW 1/4 of Section 29, T10S, R21E, S.L.B.&M. Uintah County, Utah.


T10S, R21E, S.L.B.&M.

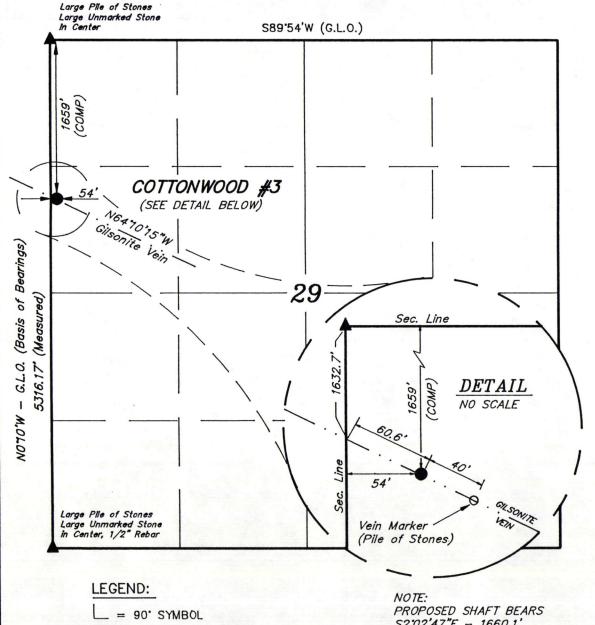

= PROPOSED GILSONITE MINE SHAFT.

= SECTION CORNERS LOCATED.

52'02'47"E - 1660.1" FROM THE NORTHWEST CORNER OF SECTION 29.

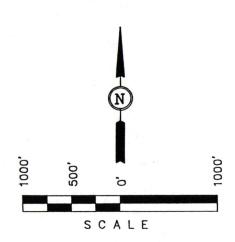

THIS IS TO CERTIFY THAT THE ABOVE PLAT WAS PREPARED FROM FIELD NOTES OF ACTUAL SURVEYS MADE BY ME OR UNDER MY SUPERVISION AND THAT THE SAME ARE TRUE AND CORRECT TO THE BEST OF MY KNOWLEDGE AND BELIEF

> REGISTERED LAND SURVEYOR REGISTRATION NO. 5709 STATE OF UTAH

UINTAH ENGINEERING & LAND SURVEYING 85 SOUTH 200 EAST - VERNAL, UTAH 84078 (801) 789-1017

SCALE 1" = 1000'	DATE SURVEYED: 5-22-92	DATE DRAWN: 6-3-92	
PARTY G.S. K.L. R.E.H.	REFERENCES G.L.O. PLA	\T	
WEATHER WARM	FILE ZIEGLER CHEMICAL		


ZIIEGILIER CHIEMIICAIL

COTTONWOOD #3

LOCATED IN SECTION 29, T10S, R21E, S.L.B.&M.



DATE: 6-2-92

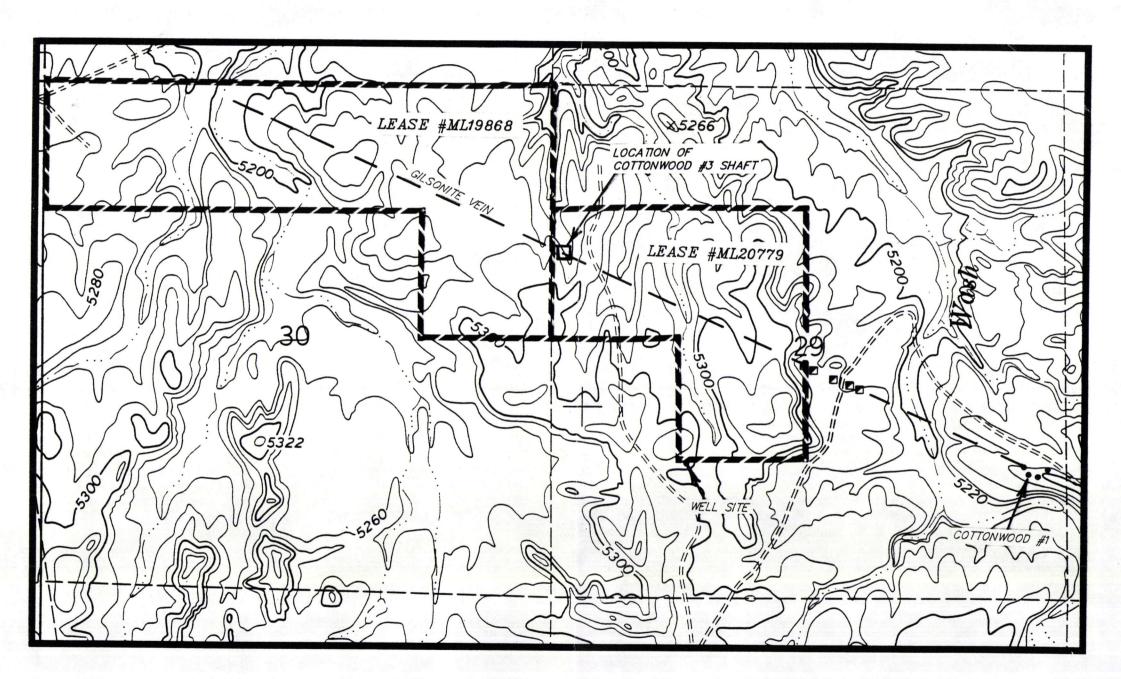


VICINITY MAP

Scale: 1" = 1000'

DOGM REC. 7-22-92

UINTAH ENGINEERING & LAND SURVEYING 85 So. 200 East Vernal, Utah

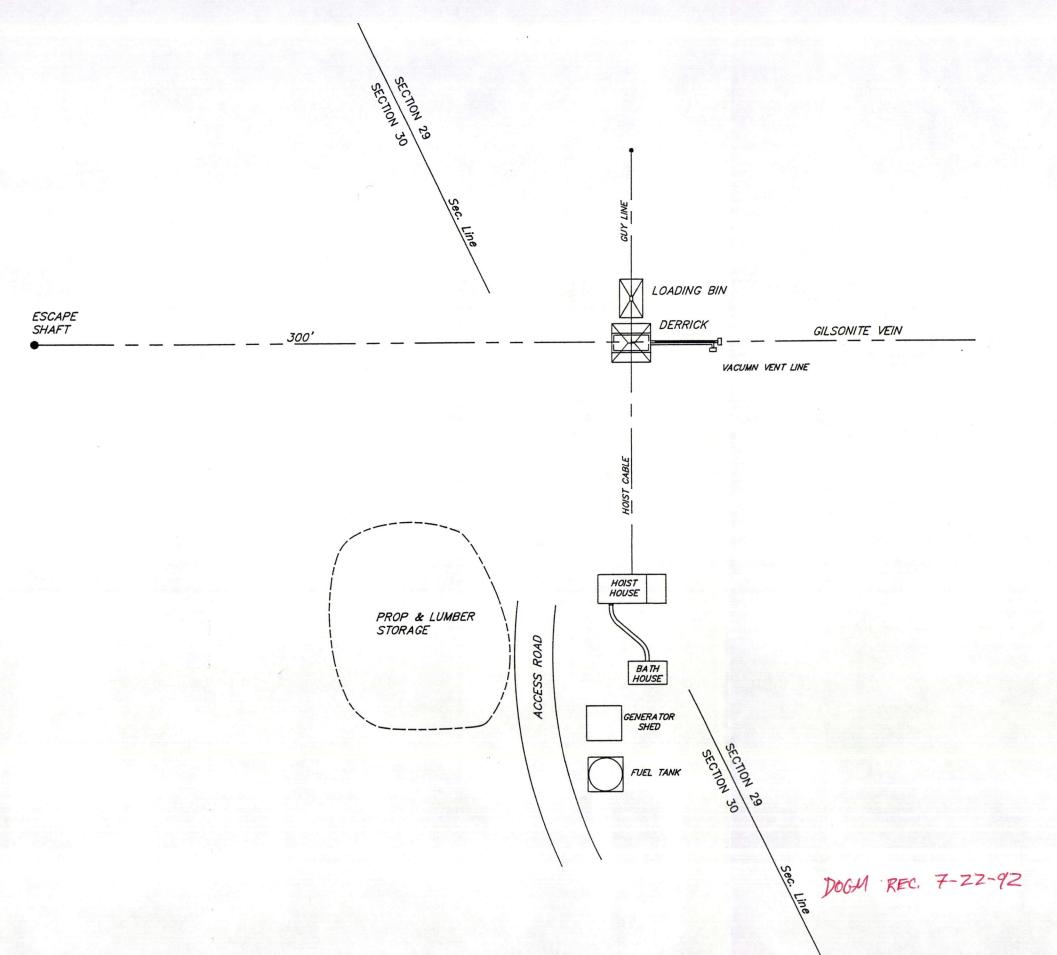

ZIEGLER CHEMICAL

COTTONWOOD #3 SITE PLAN

LOCATED IN SECTIONS 29 & 30, T10S, R21E, S.L.B.&M. UINTAH COUNTY, STATE



CERTIFICATE

THIS IS TO CERTIFY THAT THE ABOVE PLAT WAS PREPARED FROM FIELD NOTES OF ACTUAL SURVEYS MADE BY ME OR UNDER MY SUPERVISION AND THAT THE SAME ARE TRUE AND CORRECT TO THE BEST OF MY KNOWLEDGE AND BELIEF

REGISTERED LAND SURVEYOR REGISTRATION NO. 5709 STATE OF UTAH

UINTAH ENGINEERING & LAND SURVEYING

85 SOUTH 200 EAST - VERNAL, UTAH 84078

(801) 789-1017

SCALE		()	DATE SURVEYED:	DATE DRAWN:
SCALE	1" = 50'		5-22-92	6-2-92
PARTY	G.S. K.L.	R.E.H.	REFERENCES G.L.O.	PLAT
WEATHER	WARM		FILE 4 0	2 4 5


ZIEGLER CHEMICAL

COTTONWOOD #3

LOCATED IN SECTION 29, T10S, R21E, S.L.B.&M.



DATE: 6-2-92

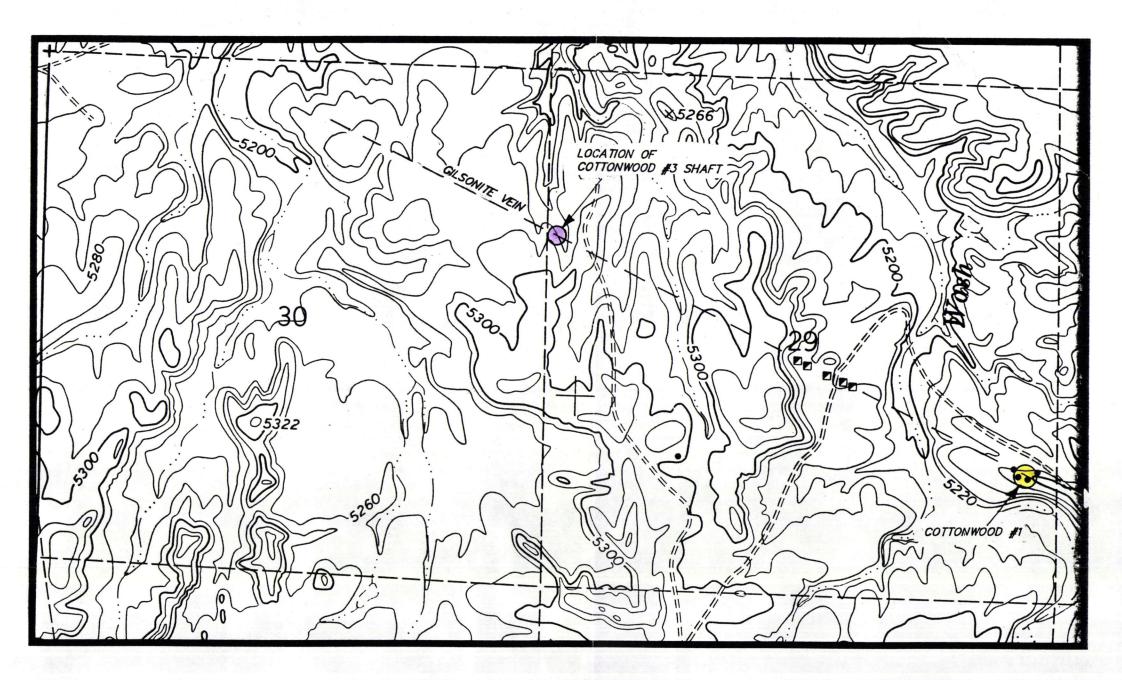

VICINITY MAP

Scale: 1" = 1000'



TO BE RECLAIMED IN 1992



PROPOSED MINING

DOGM REC. 7-22-92

UINTAH ENGINEERING & LAND SURVEYING 85 So. 200 East Vernal, Utah **M& A**

Attorneys & Counselors

DOGM PROBLEMAN

July 17, 1992

363 East Main Street Vernal, Utah 84078 801-789-4908 Fax # 789-4918

865 East 200 North (112-10) Roosevelt, Utah 84066 801-722-3928 Fax # 722-3920

Reply to:

Vernal

M/047/013

Mr. Anthony A. Gallegos
Reclamation Engineer
Department of Natural Resources
Division of Oil, Gas and Mining
355 West North Temple
3 Triad Center, Suite 350
Salt Lake City, Utah 84180-1203

RE: Ziegler Chemical, Reclamation Contract and Notice of Intention to Revise Mining Operations

Dear Mr. Gallegos:

COTION WOOD #3

Pursuant to your request in your letter to Mr. Norman Haslem with Ziegler Chemical, please find enclosed the completed Reclamation Contract, Notice of Intention to Revise Mining Operations with all related attachments and a list of gilsonite mines in the Cottonwood area.

If you have any questions with regard to the contents of this matter, please address them to the undersigned.

Very Truly yours,

MCKEACHNIE & ALLRED

Sayle F. McKeachnie

VW

cc: Norman Haslem

BECEIVED

DIVISION OF OIL GAS & MINING